# **GENERAL NOTES:**

ALL MATERIALS AND CONSTRUCTION METHODS TO CONFORM TO THE CURRENT EDITION OF THE BRITISH COLUMBIA BUILDING CODE (BCBC), GOOD CONSTRUCTION PRACTICE, AS WELL AS ANY OTHER LOCAL BUILDING CODES OR BYLAWS WHICH MAY TAKE PRECEDENCE

DIMENSIONS SHALL TAKE PRECEDENCE OVER SCALE.

Framing Lumber shall be graded #2 or better unless otherwise specified.

STAIR TREADS TO BE PLYWOOD OR SOLID WOOD AND SECURED WITH SCREWS AND SUBFLOOR ADHESIVE.

TEMPORARY HEAT REQUIRED PRIOR TO V.B. + DRYWALL INSTALLATION TO ASSIST IN DRYING OF FRAMEWORK.

MOISTURE CONTENT OF FRAMEWORK MUST NOT EXCEED 19%.

ALL SETBACKS TO BE CONFIRMED BY THE OWNER/BUILDER ALL GRADE ELEVATIONS ARE THE RESPONSIBILITY OF THE OWNER/BUILDER

THE OWNER BUILDER IS RESPONSIBLE FOR LOCATING THE FOOTPRINT OF THE STRUCTURE IN THE PROPER PLACE AS PER PLANS

CONCRETE FOUNDATION WALLS NOT SUBJECT TO SURCHARGE SHALL BE INSTALLED ON COMPACTED UNDISTURBED, INORGANIC STABLE SOILS BELOW THE DEPTH OF FROST PENETRATION WITH AN ALLOWABLE BEARING PRESSURE OF 95 kPa(2000 PSI) OR GREATER.

IF SOFTER CONDITIONS APPLY. THE BEARING CAPACITY AND SIZE OF FOOTINGS ARE TO BE DESIGNED BY A QUALIFIED ENGINEER

THE SILL PLATE IS TO BE FASTENED TO THE FOUNDATION WALL AS PER ENGINEERING PLANS.

ALL LUMBER IN CONTACT WITH CONCRETE SHALL BE TREATED OR PROTECTED BY A MOISTURE

ALL FOLINDATION WALLS ARE 200mm THICK 25MPa CONCRETE LINLESS OTHERWISE SPECIFIED.

#### FRAMING:

ALL ENGINEERED TRUSS COMPONENTS TO BE SIZED BY SUPPLIER VICTORIA TRUSS LTD. TRUSSES AND LAYOUT ARE TO BE ENGINEERED AND INSTALLED ACCORDING TO MANUFACTURERS SPECIFICATIONS

ALL SPANS AND LOADINGS SHALL CONFORM TO THE CURRENT VERSION OF THE BCBC. VERIFICATION OF ALL COMPONENTS IS THE RESPONSIBILITY OF THE OWNER/BUILDER.

ANY COMPONENTS WHICH CANNOT BE DESIGNED WITH THE BCBC SHALL BE DESIGNED BY A OUALIFIED ENGINEER.

ALIGN MOST WINDOW JAMBS W/ WINDOW/ DOOR JAMBS BELOW WHERE WITHIN 3".

IT IS ASSUMED THAT THE OWNER/BUILDER IS FAMILIAR WITH THE 2018 BCBC AND INDUSTRY STANDARDS FOR WOOD FRAME CONSTRUCTION, NOT EVERY DETAIL OF WOOD FRAMING IS SHOWN ON THESE DRAWINGS

ALL LINTELS DOUBLE 2X8 S S. SPF FOR CLEAR SPANS UP TO 5' UNLESS OTHERWISE NOTED.

EXTERIOR WALL THICKNESSES SHOWN ARE MEASURED FROM OUTSIDE OF EXTERIOR SHEATHING TO

INTERIOR WALL THICKNESS SHOWN ARE MEASURED FROM OUTSIDE OF DRYWALL TO OUTSIDE OF

ROOM MEASUREMENTS SHOWN ARE TO THE NEAREST INCH. DIMENSIONS SHOWN ARE TO THE NEAREST 1/2".

1/2" GAP IN SHEATHING.

#### TYPICAL DOOR AND WINDOW HEADER HEIGHT:

8' CEILINGS: 7'2" 10' CEILINGS: 9'2"

12' CEILINGS: 11'2"

## TYPICAL WINDOW SILL HEIGHT:

ALL ROOFING SHALL BE APPLIED TO THE MANUFACTURERS SPECIFICATIONS AND SHALL INCLUDE EAVE PROTECTION FROM ICE DAMMING AND SNOW BUILD UP.

AS PER PLUMBING ISOMETRICS

ALL PENETRATIONS THROUGH THE ROOF WILL REQUIRE FLASHING.

ALL ROOFING TO INCLUDE STEP FLASHING.

ALL EXPOSED OPENINGS TO INCLUDE FLASHING

ALL FLASHING END DAMS TO BE 25mm (1") HIGH.

FRAME OPENING TO BE 2" WIDER THAN DOOR.

FRAME HEIGHT 83" FOR EXTERIOR DOORS AND 82.5" FOR INTERIOR DOORS UNLESS NOTED

FRAME OPENING 1 1/4" WIDER THAN BIFOLD DOORS AND FRAME HEIGHT IS 81.5".

ALL INTERIOR DOORS TO BE AT LEAST 30" WIDE UNLESS OTHERWISE SPECIFIED

ALL WINDOWS, DOORS & SKYLIGHTS TO CONFORM TO NAFS-08 AND THE CANADIAN SUPPLEMENT TO NAFS FENESTRATION PERFORMANCE REQUIREMENTS:

CLASS R - PG 30 - +'VE/-'VE DP = 1440Pa/1440Pa

WATER PENETRATION RESISTANCE = 220Pa

CANADIAN AIR INFILTRATION-EXFILTRATION = A2

WINDOW/DOOR LABELS TO BE LEFT IN PLACE UNTIL FINAL INSPECTION.

ALL WINDOWS IMMEDIATELY ADJACENT TO BATH TUBS TO BE SAFETY GLASS

#### WINDOW SCHEDULE

TYPICAL WINDOW IS 3660 (36 x 60"). SAFETY AND EVAC AS INDICATED.

1ST FLOOR: ONE 6036 (60 x 36") WINDOW AS INDICATED. 3RD FLOOR: ONE 4848 (48 x 48") WINDOW AS INDICATED

#### DOOR SCHEDULE

TYPICAL EXTERIOR DOOR IS 3882 (38 x 82") 1ST FLOOR: TWO 108-84 GARAGE (108 x 84") 1ST FLOOR: ONE 7680 SLIDING GLASS (76 x 80") 2ND FLOOR: ONE 4884 MAIN DOOR (48 x 48")

#### GUARDS/HANDRAILS:

INSTALL GRASPABLE HANDRAIL TO ALL INTERIOR STAIRS AT 34" TO 38" ABOVE STAIR NOSING.

INSTALL GUARDS AT ALL BALCONIES, DECKS AND PORCHES GREATER THAN 2' ABOVE GRADE.

INSTALL GUARD AT 42" HEIGHT WHERE SURFACE IS GREATER THAN 6' ABOVE ADJACENT SURFACE, OTHERWISE 36" GUARDRAIL ALLOWABLE.

TYPICAL RAILING USING "PEAK CABLE RAILING" SYSTEM AS DETAILED ON PEAKPRODUCTS.COM

#### VENTILATION:

PROVIDE ATTIC ACCESS AND VENTILATION IN ACCORDANCE WITH BCBC

PROVIDE HEATING, MECHANICAL VENTILATION, AND AIR CONDITIONING WHERE REQUIRED IN ACCORDANCE WITH BCBC AND LOCAL BYLAWS.

MECHANICAL CONTRACTOR TO PROVIDE MECHANICAL CHECKLIST COMPLETE WITH FAN & DUCT SIZES PRIOR TO FRAMING INSPECTION.

SMOKE/CARBON MONOXIDE ALARMS TO BE PROVIDED ON EVERY FLOOR AND ARE TO BE HARDWIRED AND WITHIN 5m OF EACH BEDROOM, IN EVERY SUITE, AND INTERCONNECTED TO ALL

SMOKE ALARMS TO ALSO BE PROVIDED IN EVERY BEDROOM.

ALL SWITCHES & OUTLETS INTENDED FOR OCCUPANT USE TO BETWEEN 455mm - 1200mm

ALL SMOKE ALARM LOCATIONS SHALL BE OF THE PHOTO-ELECTRIC TYPE INTERCONNECTIED SO THAT THE ACTUATION OF ANY ONE SMOKE ALARM CAUSES ALL OTHER SMOKE ALARMS TO SOUND.

BEDROOM WINDOWS FOR EGRESS SHALL HAVE OPENINGS WITH AREAS NOT LESS THAN 3.8 SQFT. WITH NO DIMENSION LESS THAN 15".

# 3631 Goldstream Heights Dr.

Malahat, VOR 2L0

**Adam Withers** 



# **COVER SHEET & GENERAL INFO**

**A-001** Cover Sheet

A-002 Site Plan

# **PLANS:**

**A-100** Foundation Plan

**A-101** 1st Floor Plan

**A-102** 2nd Floor Plan A-103 3rd Floor Plan

A-104 Roof Plan

# **ELEVATIONS:**

A-201 Elevations North

A-202 Elevations South

**A-203** Elevations East + West

# **SECTIONS:**

**A-301** Cross Section North + South

**A-302** Cross Section East + West


# **DETAILS:**

**A-401** Radon + Mechanical

A-402 Clading Detail

A-403 Plumbing Detail

**A-404** Perspective Views

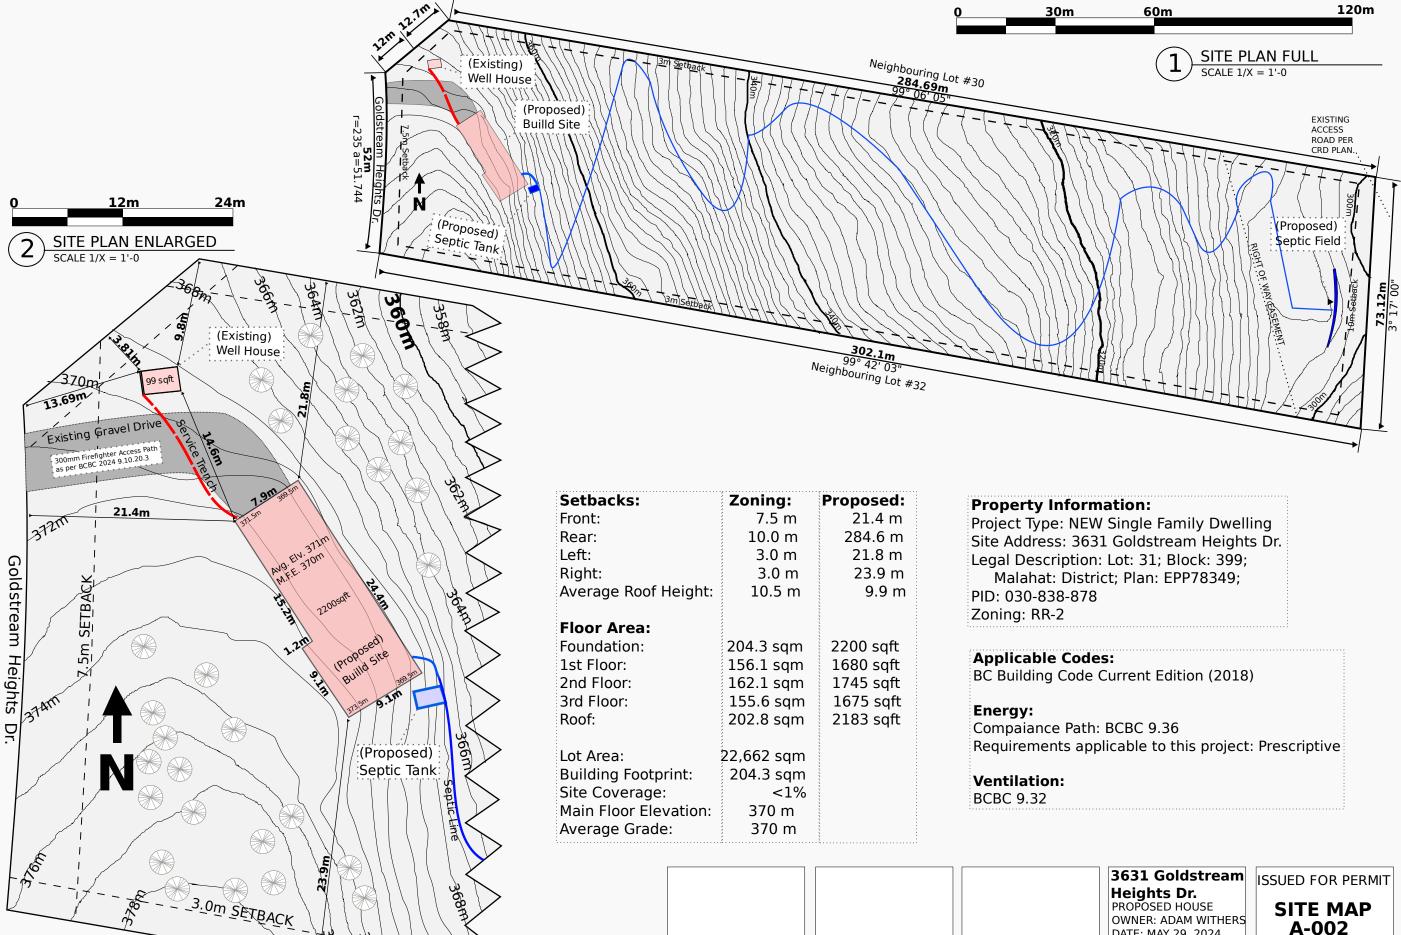


A-002

PRINTED MAY 29, 2024 ISSUED:

DATE: MAY 29, 2024 SCALE: AS NOTED

DESIGN: OWNER

DRAWN: F.B.

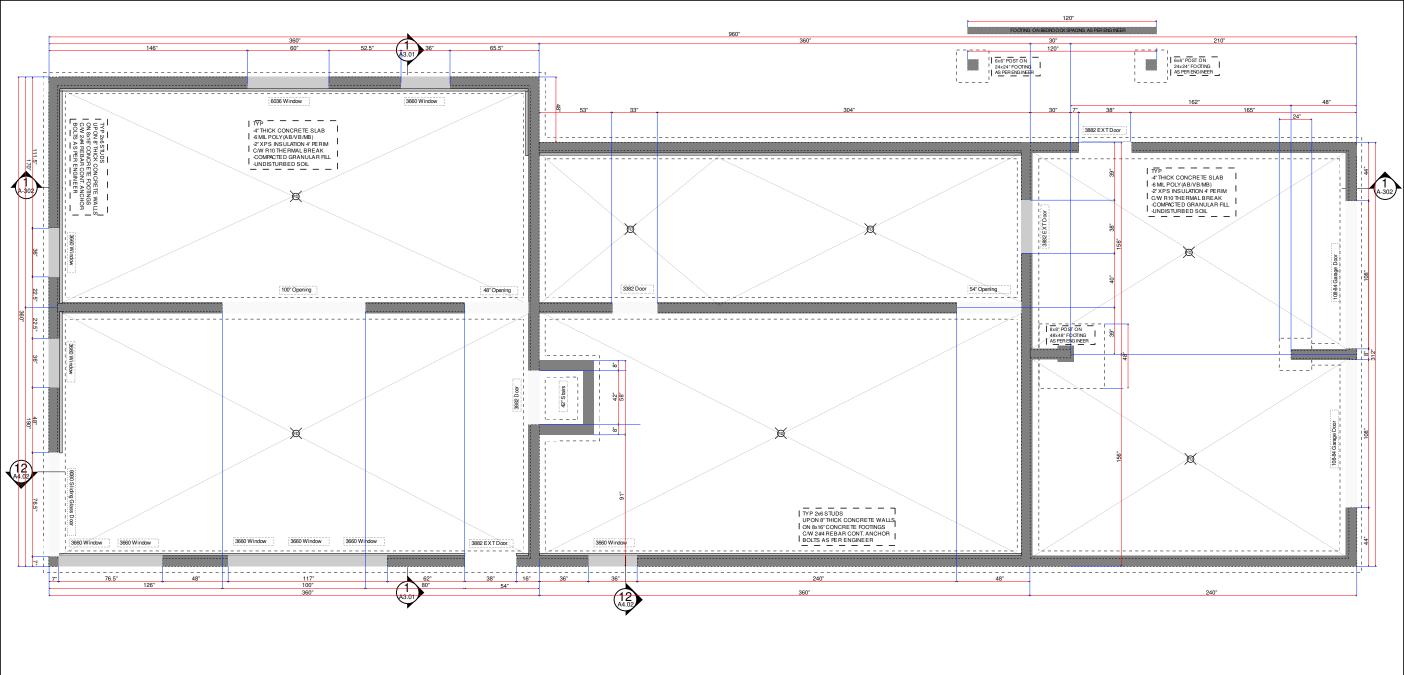



2x4 PARTITION WALL

2x6 EXTERIOR WALL INSULATED 2x6 INTERIOR WALL STRUCTURAL

FOUNDATION WALL FOUNDATION FROST WALL

H.WIRED INTERCON. CO DETECTOR H.WIRED INTERCON. IONIC SMOKE DET.

BATH FAN: 35CFM INTERMIT. KITCHEN FAN: 50CFM INTERMIT.

CONTINUOUS PRL. EXHAUST FAN FRESH AIR SUPPLY PASSIVE AIR VENT

WINDOW IN CONCRETE DETAIL DOOR IN CONCRETE DETAIL




# 3631 Goldstream Heights Dr. PROPOSED HOUSE DATE: MAY 29, 2024

OWNER: ADAM WITHERS SCALE: AS NOTED DESIGN: OWNER DRAWN: F.B.

ISSUED FOR PERMIT **FOUNDATION PLAN** A-100 **PRINTED MAY 29, 2024** 

ISSUED:

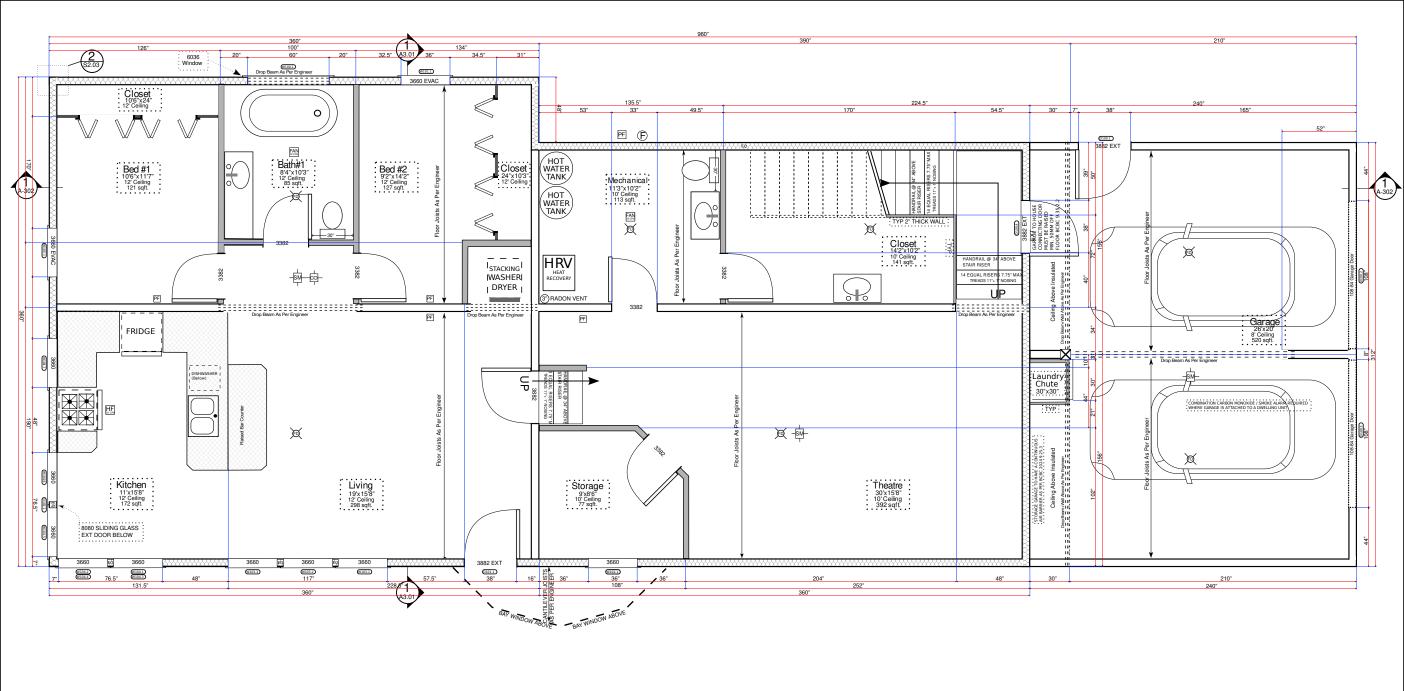



=2x2 CLOSET WALL 2x4 PARTITION WALL

2x6 EXTERIOR WALL INSULATED 2x6 INTERIOR WALL STRUCTURAL

> FOUNDATION WALL FOUNDATION FROST WALL

H.WIRED INTERCON. CO DETECTOR H.WIRED INTERCON. IONIC SMOKE DET.

BATH FAN: 35CFM INTERMIT. KITCHEN FAN: 50CFM INTERMIT.

CONTINUOUS PRL. EXHAUST FAN FRESH AIR SUPPLY PASSIVE AIR VENT


COLUMN ■■■■ BEAM FLOOR-DRAIN
 1.06m RAILING COLUMN



# 3631 Goldstream OWNER: ADAM WITHERS

Heights Dr. PROPOSED HOUSE DATE: MAY 29, 2024 SCALE: AS NOTED DESIGN: OWNER DRAWN: F.B.

ISSUED FOR PERMIT **1ST FLOOR PLAN A-101** 

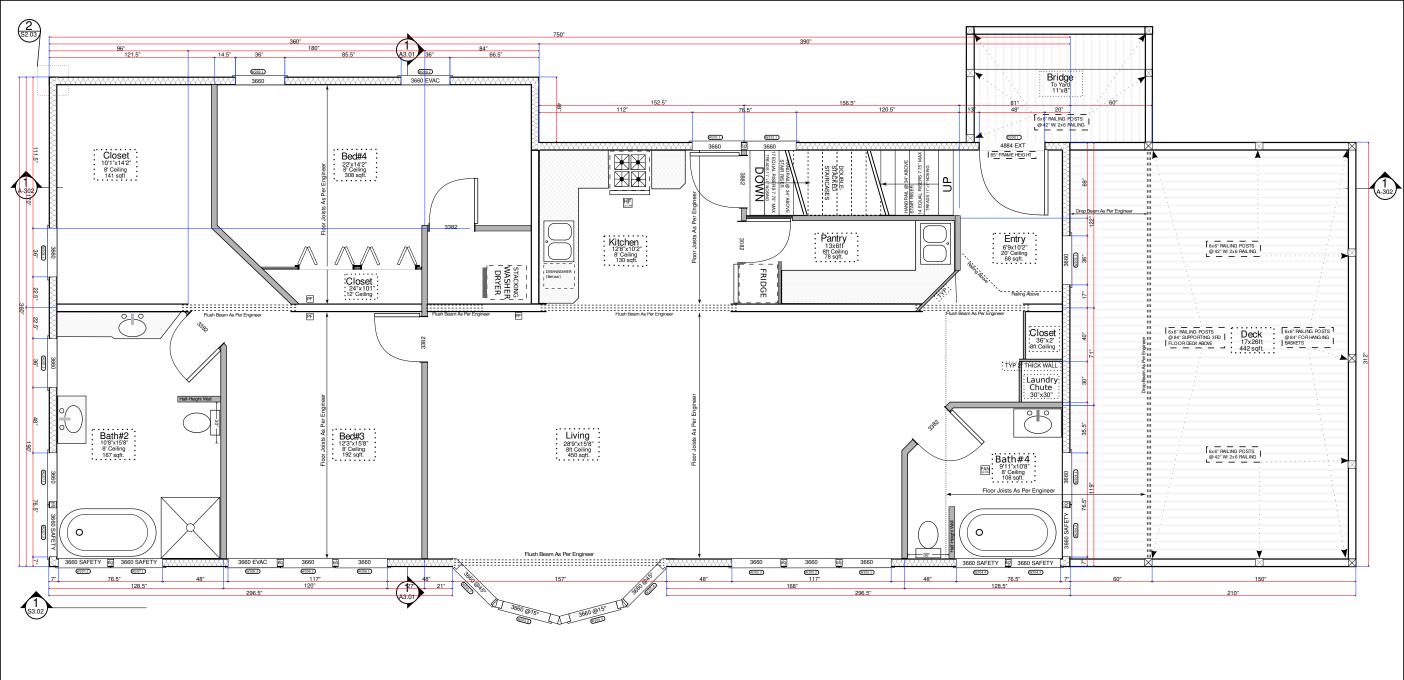




2x6 INTERIOR WALL STRUCTURAL FOUNDATION WALL FOUNDATION FROST WALL

H.WIRED INTERCON. CO DETECTOR H.WIRED INTERCON. IONIC SMOKE DET. BATH FAN: 35CFM INTERMIT.


KITCHEN FAN: 50CFM INTERMIT. CONTINUOUS PRL. EXHAUST FAN

FRESH AIR SUPPLY PASSIVE AIR VENT COLUMN ■■■■ BEAM FLOOR-DRAIN
 1.06m RAILING COLUMN

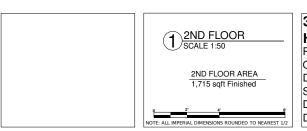

3631 Goldstream Heights Dr. PROPOSED HOUSE OWNER: ADAM WITHERS DATE: MAY 29, 2024 SCALE: AS NOTED DESIGN: OWNER DRAWN: F.B.


ISSUED FOR PERMIT **2ND FLOOR PLAN A-102** 

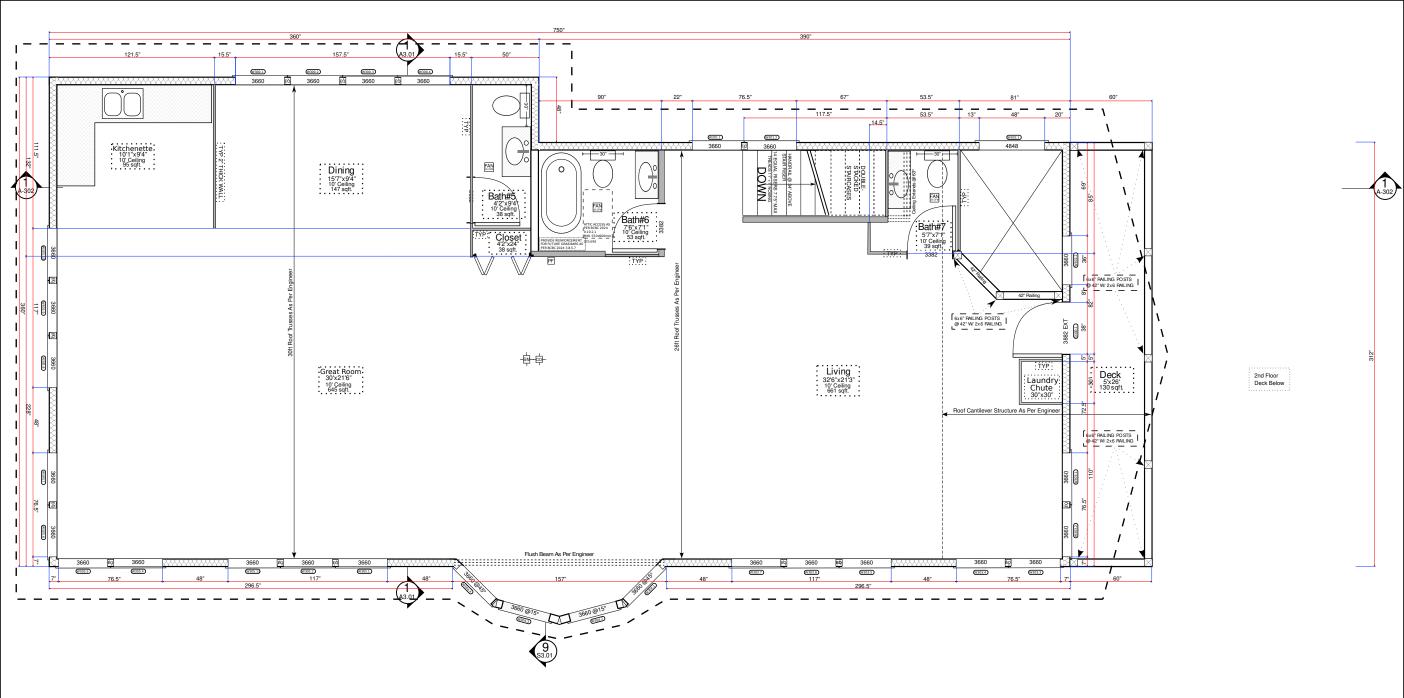




=2x2 CLOSET WALL 2x4 PARTITION WALL 2x6 EXTERIOR WALL INSULATED 2x6 INTERIOR WALL STRUCTURAL FOUNDATION WALL FOUNDATION FROST WALL H.WIRED INTERCON. CO DETECTOR H.WIRED INTERCON. IONIC SMOKE DET. BATH FAN: 35CFM INTERMIT. KITCHEN FAN: 50CFM INTERMIT. CONTINUOUS PRL. EXHAUST FAN FRESH AIR SUPPLY PASSIVE AIR VENT

COLUMN ■■■■ BEAM FLOOR-DRAIN
 1.06m RAILING COLUMN

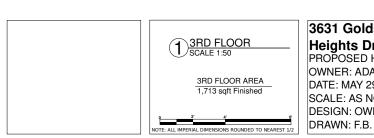

#### 3631 Goldstream Heights Dr. PROPOSED HOUSE OWNER: ADAM WITHERS DATE: MAY 29, 2024 SCALE: AS NOTED DESIGN: OWNER

ISSUED FOR PERMIT **3RD FLOOR PLAN A-103** 

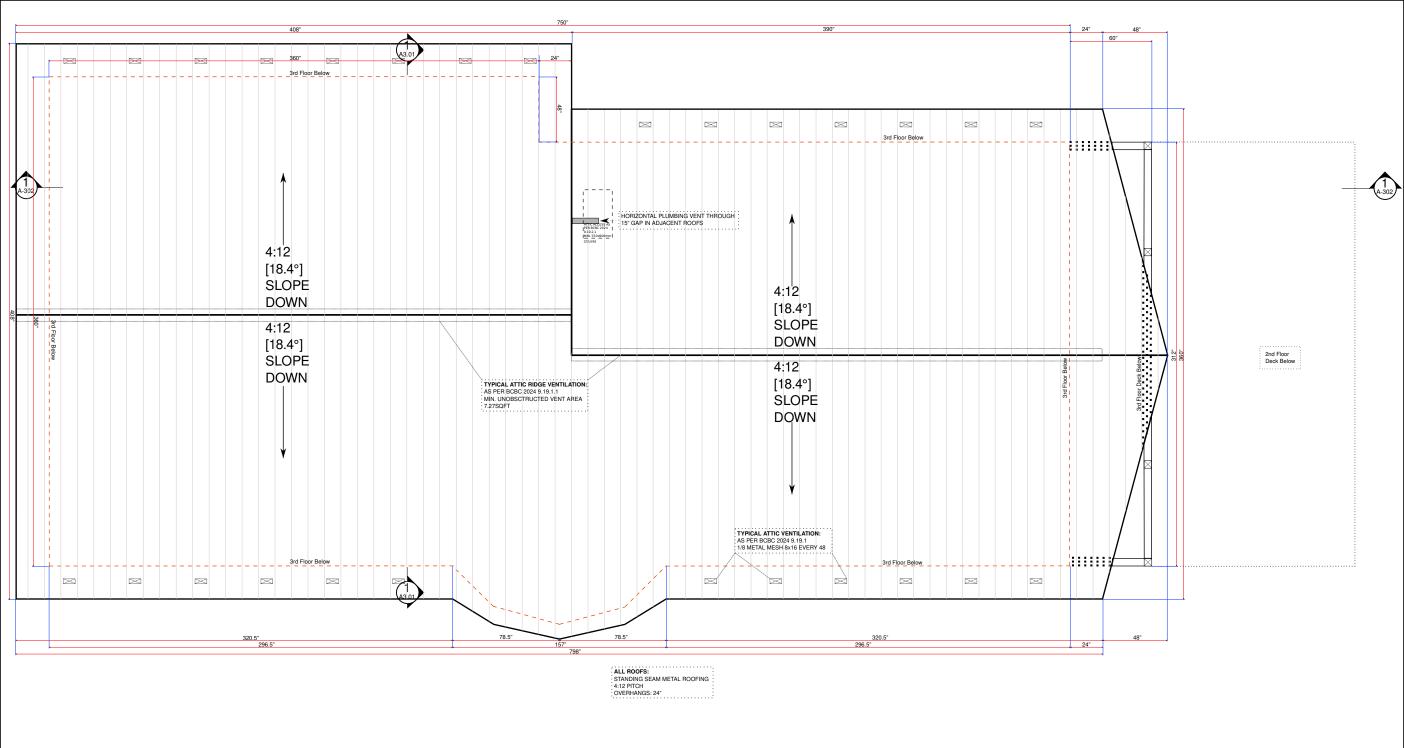

# **PLAN LEGEND**

=2x2 CLOSET WALL 2x4 PARTITION WALL

2x6 EXTERIOR WALL INSULATED 2x6 INTERIOR WALL STRUCTURAL FOUNDATION WALL

H.WIRED INTERCON. CO DETECTOR
H.WIRED INTERCON. JONIO 2012 H.WIRED INTERCON. IONIC SMOKE DET.

BATH FAN: 35CFM INTERMIT. KITCHEN FAN: 50CFM INTERMIT.

CONTINUOUS PRL. EXHAUST FAN FRESH AIR SUPPLY PASSIVE AIR VENT

TODO SCUPPER from jane? I can't find it




# 3631 Goldstream Heights Dr.

PROPOSED HOUSE OWNER: ADAM WITHERS DATE: MAY 29, 2024 SCALE: AS NOTED DESIGN: OWNER DRAWN: F.B.

ISSUED FOR PERMIT **ROOF PLAN** 

A-104

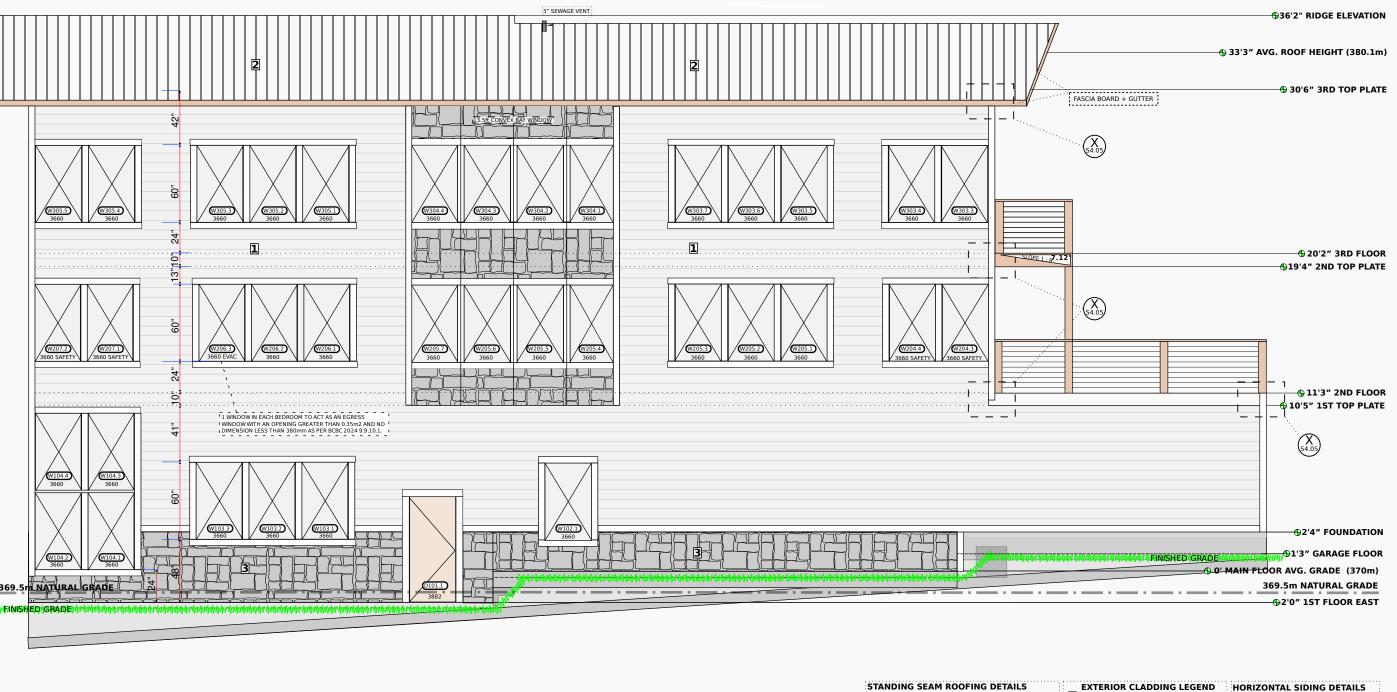

TO DO: WHICH DETAILS SHOULD GO HERE? Choose from the details page \$4.05

#### STANDING SEAM ROOFING DETAILS BUILDING PAPER UNDERLAY c/w ON 2 PLIES 15# ASPHALT SAT. FELT EAVE PROTECTION ON 0.5" PLY / ROOF SHEATHING ON

SPATIAL SEPARATION AS PER BCBC 9.10.15.4

: LIMITING DISTANCE 32.8ft 10m PROPOSED DISTANCE 873ft 266m EXPOSING BUILDING FACE 2103sqft 195msq : ALLOWABLE OPENINGS : ALLOWABLE OPENINGS 34% 34% PROPOSED OPENING AREA 560sqft 52m PROPOSED OPENINGS 26.6% 26.6%

# EXTERIOR CLADDING LEGEND 1 7.5" HORIZONTAL PLANKS PAINTED 8.25" HARDIBOARD SIDING ON STANDING SEAM METAL ROOFING 10mm P.T STRAPPING @ 16" o/c 3 STONE VENEER TYVEK BUILDING PAPER ON


PRE-ENG ROOF TRUSSES (SEE ATTACHED)(TYP): FOUNDATION DETAILS

4" 32mpa SLAB ON GRADE ON MIN. 0.15mm POLYETHYLENE VAPOUR BARRIER ON MIN. 6" COMPACTED GRAVEL (TYP) 1/2" EXT. PLY/ SHEATHING ON 2x6 EXTERIOR WALLS (TYP) **RAILING SPECIFICATIONS:** 

10mm P.T STRAPPING @ 16" o/c ON

6x6 POSTS @ 42" 1/8" STEEL TENSION CABLE 9 LINES SPACED AT 4.5"

TO DO: BRandon review heights with me

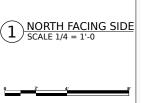

# 3631 Goldstream Heights Dr.

PROPOSED HOUSE OWNER: ADAM WITHERS DATE: MAY 29, 2024 SCALE: AS NOTED

DESIGN: OWNER DRAWN: F.B.

ISSUED FOR PERMIT

# **NORTH ELEVATION** A-201

TO DO: WHICH DETAILS SHOULD GO HERE? Choose from the details page \$4.05

#### STANDING SEAM ROOFING DETAILS

BUILDING PAPER UNDERLAY c/w ON 2 PLIES 15# ASPHALT SAT. FELT EAVE PROTECTION ON :0.5" PLY / ROOF SHEATHING ON

#### SPATIAL SEPARATION AS PER BCBC 9.10.15.4

LIMITING DISTANCE 52.1ft 15.8m PROPOSED DISTANCE EXPOSING BUILDING FACE 2103sqft 195msq ALLOWABLE OPENINGS 34% 34% PROPOSED OPENING AREA 244sqft 22.7m PROPOSED OPENINGS 11.6% 11.6%

#### EXTERIOR CLADDING LEGEND

1 7.5" HORIZONTAL PLANKS PAINTED 8.25" HARDIBOARD SIDING ON STANDING SEAM METAL ROOFING 10mm P.T STRAPPING @ 16" o/c STONE VENEER TYVEK BUILDING PAPER ON

#### PRE-ENG ROOF TRUSSES (SEE ATTACHED)(TYP): FOUNDATION DETAILS

4" 32mpa SLAB ON GRADE ON MIN. 0.15mm POLYETHYLENE VAPOUR


24.6ft 7.5m ON MIN. 6" COMPACTED GRAVEL (TYP)

#### HORIZONTAL SIDING DETAILS

10mm P.T STRAPPING @ 16" o/c ON 1/2" EXT. PLY/ SHEATHING ON 2x6 EXTERIOR WALLS (TYP)

# RAILING SPECIFICATIONS:

6x6 POSTS @ 42" 1/8" STEEL TENSION CABLE 9 LINES SPACED AT 4.5"

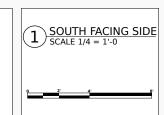


# 3631 Goldstream Heights Dr.


PROPOSED HOUSE OWNER: ADAM WITHERS DATE: MAY 29, 2024

SCALE: AS NOTED **DESIGN: OWNER** DRAWN: F.B.

**ISSUED FOR PERMIT** 

# SOUTH ELEVATION **A-202**

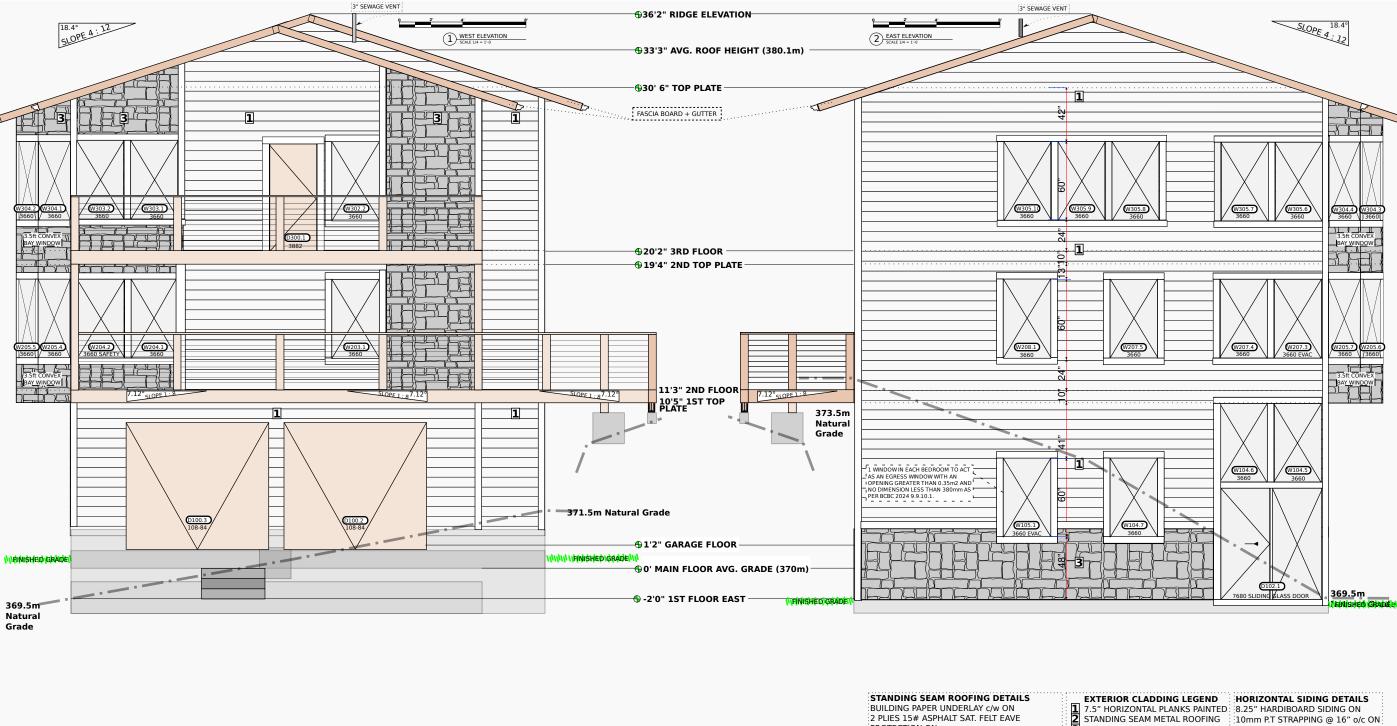

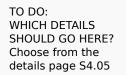

#### PRE-ENG ROOF TRUSSES (SEE ATTACHED)(TYP): FOUNDATION DETAILS WEST **SPATIAL SEPARATION AS PER BCBC 9.10.15.4** 9.8ft LIMITING DISTANCE 85ft 25.9m PROPOSED DISTANCE 65ft 19.8m EXPOSING BUILDING FACE 1135sqft 105msq 1015saft 94msa 34% 34% ALLOWABLE OPENINGS 34% 34% PROPOSED OPENING AREA 240sqft 22msq 266sqft 25msq 26% 26% PROPOSED OPENINGS

0.5" PLY / ROOF SHEATHING ON

PROTECTION ON

STONE VENEER

4" 32mpa SLAB ON GRADE ON MIN. 0.15mm POLYETHYLENE VAPOUR BARRIER

9.8ft 3.0m ON MIN. 6" COMPACTED GRAVEL (TYP)

DRAWN: F.B.

#### 10mm P.T STRAPPING @ 16" o/c ON

TYVEK BUILDING PAPER ON 1/2" EXT. PLY/ SHEATHING ON 2x6 EXTERIOR WALLS (TYP)

#### RAILING SPECIFICATIONS:

6x6 POSTS @ 42" 1/8" STEEL TENSION CABLE 9 LINES SPACED AT 4.5"




A-203

PRINTED MAY 29, 2024 ISSUED:

**EAST+WEST** 

**SECTION** 

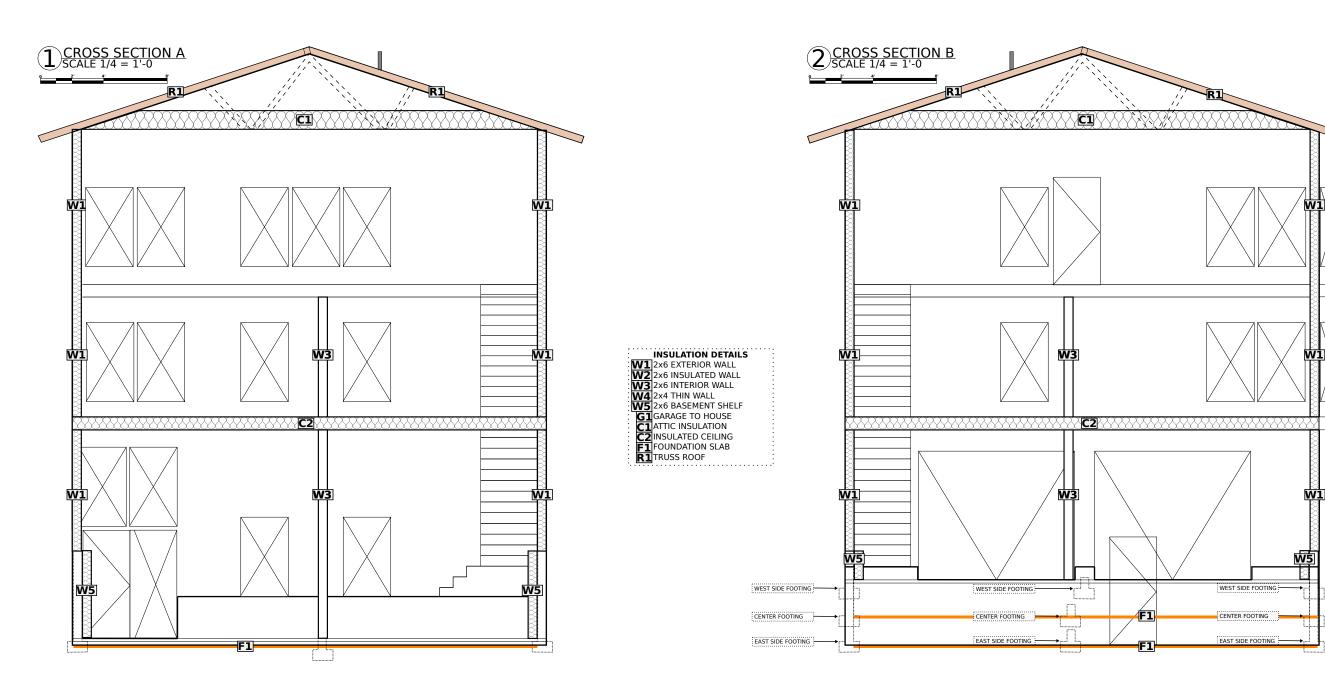

# **SECTION LEGEND:**

**APPLIES TO A3.01 +A3.02** 

# **WALL TYPES:**

# W1 - 2x6 EXTERIOR WALL CLADDING AS PER ELEVATIONS

9MM P.T. STRAPPING FASTENED TO FRAMING TYVEK HOUSE WRAP (MB) 7/16" OSC SHEATING AS PER ENGINEER 2x6 STUDS @ 16" O.C. R-19 (COMPRESSED) BATT INSULATION 6 MILL POLY (AB/VB) 1/2" GYPSUM BOARD PAINTED

# W2 - 2x6 INSULATED WALL

1/2" GYPSUM BOARD PAINTED 2x6 STUDS @ 16" O.C. R-19 (COMPRESSED) BATT INSULATION 1/2" GYPSUM BOARD PAINTED

# W3 - 2x6 INTERIOR WALL

1/2" GYPSUM BOARD PAINTED 2x6 STUDS @ 16" O.C. 1/2" GYPSUM BOARD PAINTED

# W4 - 2x4 THIN WALL

1/2" GYPSUM BOARD PAINTED 2x4 STUDS @ 16" O.C. 1/2" GYPSUM BOARD PAINTED

#### **W5 - 2x6 BASEMENT SHELF**

1/2" GYPSUM BOARD PAINTED 6MILL POLY (AB/VB) 2x6 STUDS @ 16" O.C. R-19 (COMPRESSED) BATT 8" CONCRETE FOOTING CLADDING AS PER ELEVATIONS

#### **SLAB TYPES:**

#### **F1 - FOUNDATION SLAB**

4" THICK CONCRETE SLAB
6 MIL POLY.
2." XPS RIGID INSULATION 4' PERIM.
2" THERMAL BREAK @ SLAB EDGE
COMPACTED 3/4" MINUS
UNDISTURBED SOIL

## **ROOF TYPES:**

#### **R1 - TRUSS ROOF**

STANDING SEAM METAL ROOFING
1/2" PLYWOOD C/W H CLIPS
TRUSSES AS PER ENGINEER
R40 BLOWN CELLULOSE INSULATION
6MILL POLY (AB/VB)
1/2" GYPSUM BOARD PAINTED
ROOF VENTED 1:300

#### **CEILING TYPES:**

#### **C1 - ATTIC INSULATION**

FINISHED FLOORING
3/4" T&G PLYWOOD
FLOOR JOISTS AS PER ENGINEER
CROSS BRIDGING
1/2" GYPSUM BOARD

#### **C2 - INSULATED CEILING**

FINISHED FLOORING 3/4" T&G PLYWOOD FLOOR JOISTS AS PER ENGINEER R-20 (COMP.) BATT INSULATION CROSS BRIDGING 1/2" GYPSUM BOARD


#### **C2 - GARAGE TO HOUSE**

FINISHED FLOORING
3/4" T&G PLYWOOD
FLOOR JOISTS AS PER ENGINEER
R-20 (COMP.) BATT INSULATION
CROSS BRIDGING
VAPOUR BARRIER
1/2" GYPSUM BOARD

# **3631 Goldstream Heights Dr.**PROPOSED HOUSE

PROPOSED HOUSE OWNER: ADAM WITHERS DATE: MAY 29, 2024 SCALE: AS NOTED DESIGN: OWNER DRAWN: F.B.

# ISSUED FOR PERMIT CROSS SECTION NORTH+SOUTH A-301

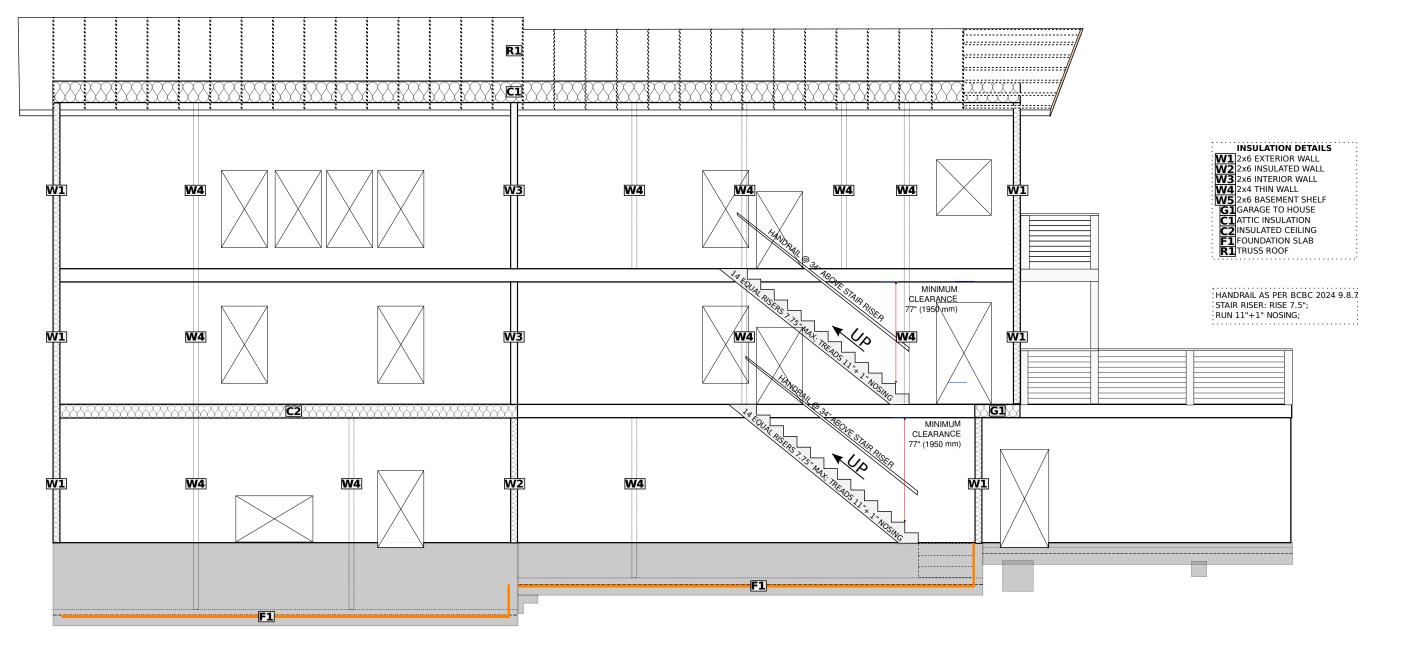

# **SECTION LEGEND:**

**APPLIES TO A3.01 +A3.02** 

#### **WALL TYPES: W1 - 2x6 EXTERIOR WALL**

**CLADDING AS PER ELEVATIONS** 9MM P.T. STRAPPING FASTENED TO FRAMING TYVEK HOUSE WRAP (MB) 7/16" OSC SHEATING AS PER ENGINEER 2x6 STUDS @ 16" O.C. R-19 (COMPRESSED) BATT INSULATION 6 MILL POLY (AB/VB)

1/2" GYPSUM BOARD PAINTED **W2 - 2x6 INSULATED WALL** 

1/2" GYPSUM BOARD PAINTED 2x6 STUDS @ 16" O.C. R-19 (COMPRESSED) BATT INSULATION 1/2" GYPSUM BOARD PAINTED

# **W3 - 2x6 INTERIOR WALL**

1/2" GYPSUM BOARD PAINTED 2x6 STUDS @ 16" O.C. 1/2" GYPSUM BOARD PAINTED W4 - 2x4 THIN WALL

1/2" GYPSUM BOARD PAINTED 2x4 STUDS @ 16" O.C. 1/2" GYPSUM BOARD PAINTED

#### W5 - 2x6 BASEMENT SHELF

1/2" GYPSUM BOARD PAINTED 6MILL POLY (AB/VB) 2x6 STUDS @ 16" O.C. R-19 (COMPRESSED) BATT 8" CONCRETE FOOTING **CLADDING AS PER ELEVATIONS** 

#### **SLAB TYPES:**

#### **F1 - FOUNDATION SLAB**

4" THICK CONCRETE SLAB 6 MIL POLY. 2." XPS RIGID INSULATION 4' PERIM. 2" THERMAL BREAK @ SLAB EDGE COMPACTED 3/4" MINUS

#### UNDISTURBED SOIL **ROOF TYPES:**

#### **R1 - TRUSS ROOF**

STANDING SEAM METAL ROOFING 1/2" PLYWOOD C/W H CLIPS TRUSSES AS PER ENGINEER **R40 BLOWN CELLULOSE INSULATION** 6MILL POLY (AB/VB) 1/2" GYPSUM BOARD PAINTED **ROOF VENTED 1:300** 

#### **CEILING TYPES:**

#### **C1 - ATTIC INSULATION**

FINISHED FLOORING 3/4" T&G PLYWOOD FLOOR JOISTS AS PER ENGINEER **CROSS BRIDGING** 1/2" GYPSUM BOARD

#### **C2 - INSULATED CEILING**

FINISHED FLOORING 3/4" T&G PLYWOOD FLOOR JOISTS AS PER ENGINEER R-20 (COMP.) BATT INSULATION **CROSS BRIDGING** 1/2" GYPSUM BOARD

## **C2 - GARAGE TO HOUSE**


FINISHED FLOORING 3/4" T&G PLYWOOD FLOOR JOISTS AS PER ENGINEER R-20 (COMP.) BATT INSULATION **CROSS BRIDGING VAPOUR BARRIER** 1/2" GYPSUM BOARD

TO DO:


# 3631 Goldstream Heights Dr.

PROPOSED HOUSE OWNER: ADAM WITHERS DATE: MAY 29, 2024 SCALE: AS NOTED DESIGN: OWNER DRAWN: F.B.

ISSUED FOR PERMIT **CROSS SECTION** EAST + WEST A-302

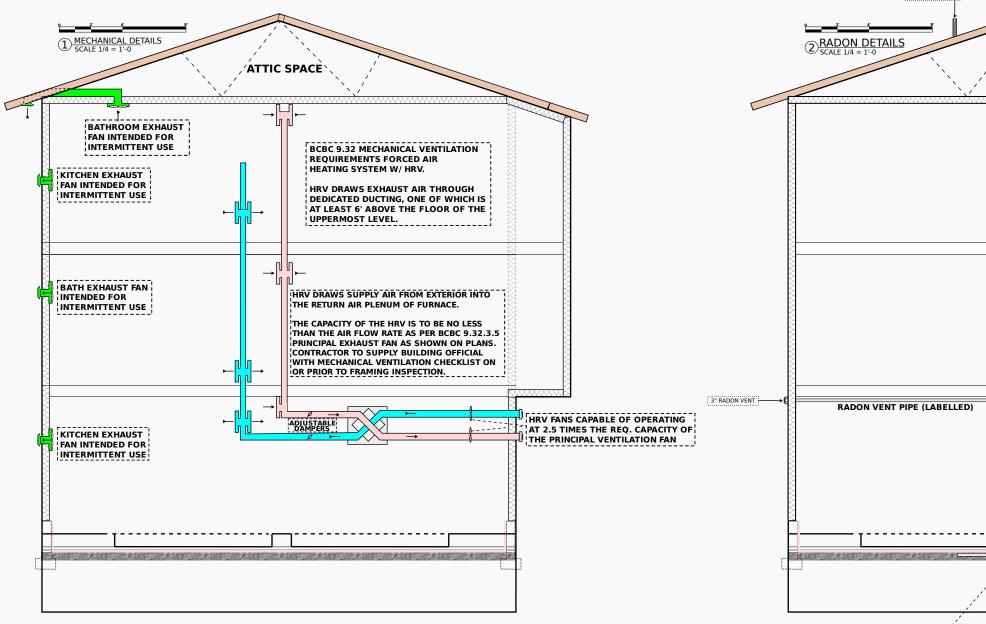


TO DO: WHICH DETAILS SHOULD GO HERE? Choose from the details page S4.05

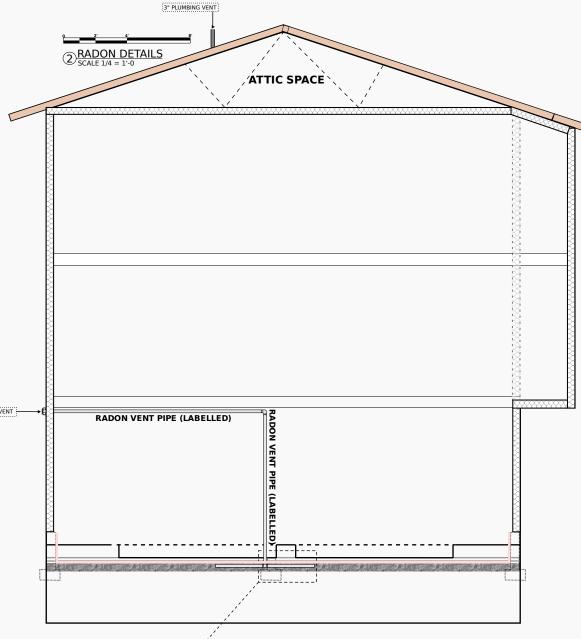


# **3631 Goldstream** ISSUED FOR PERMIT Heights Dr. PROPOSED HOUSE OWNER: ADAM WITHERS

DATE: MAY 29, 2024 SCALE: AS NOTED DESIGN: OWNER DRAWN: F.B.

**CROSS SECTION DETAILS** A-401

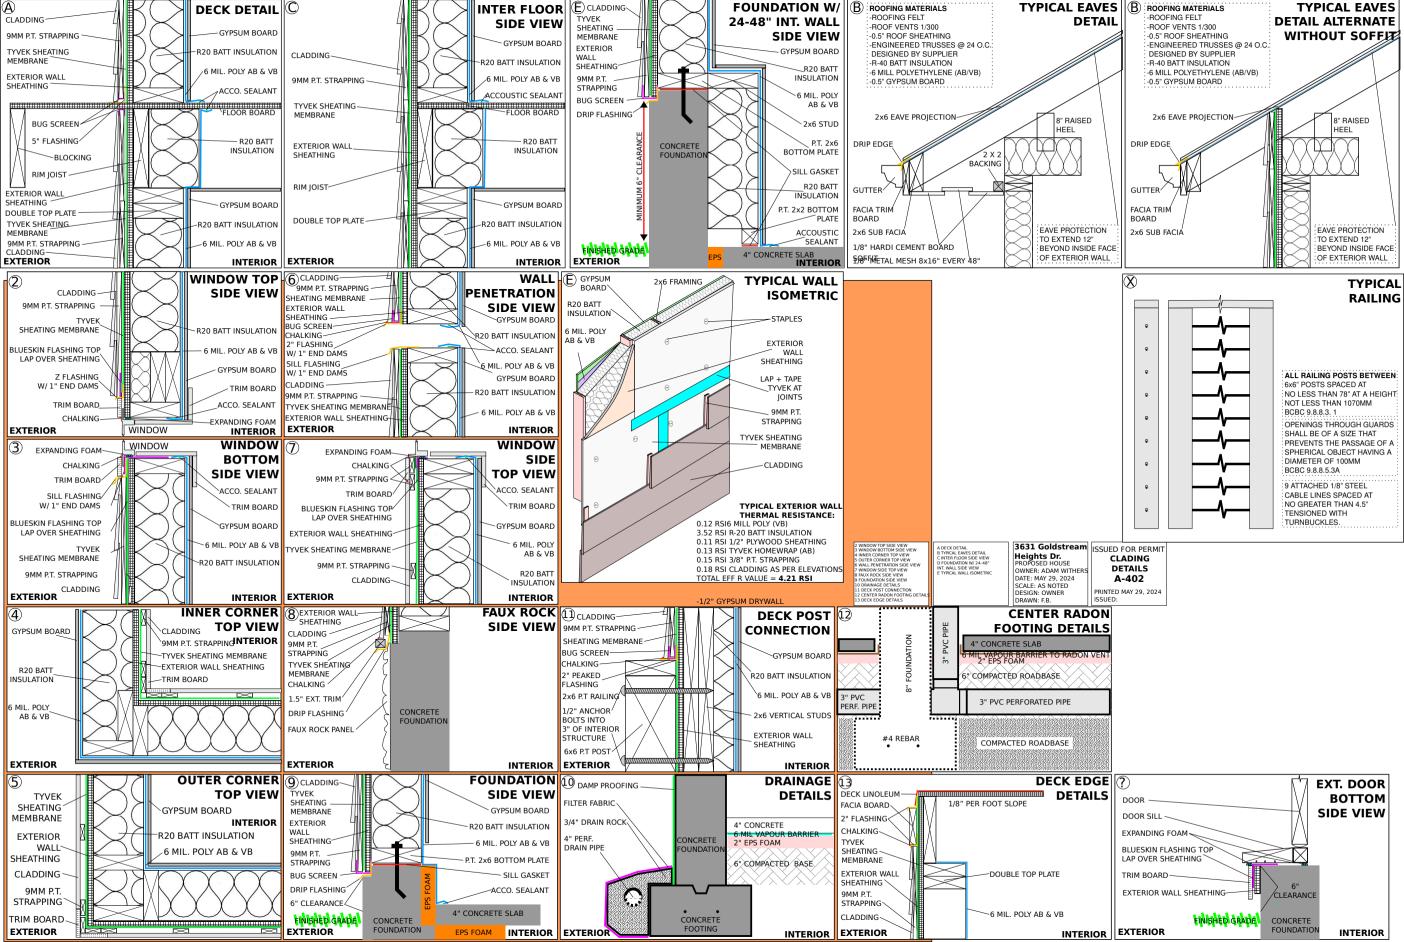

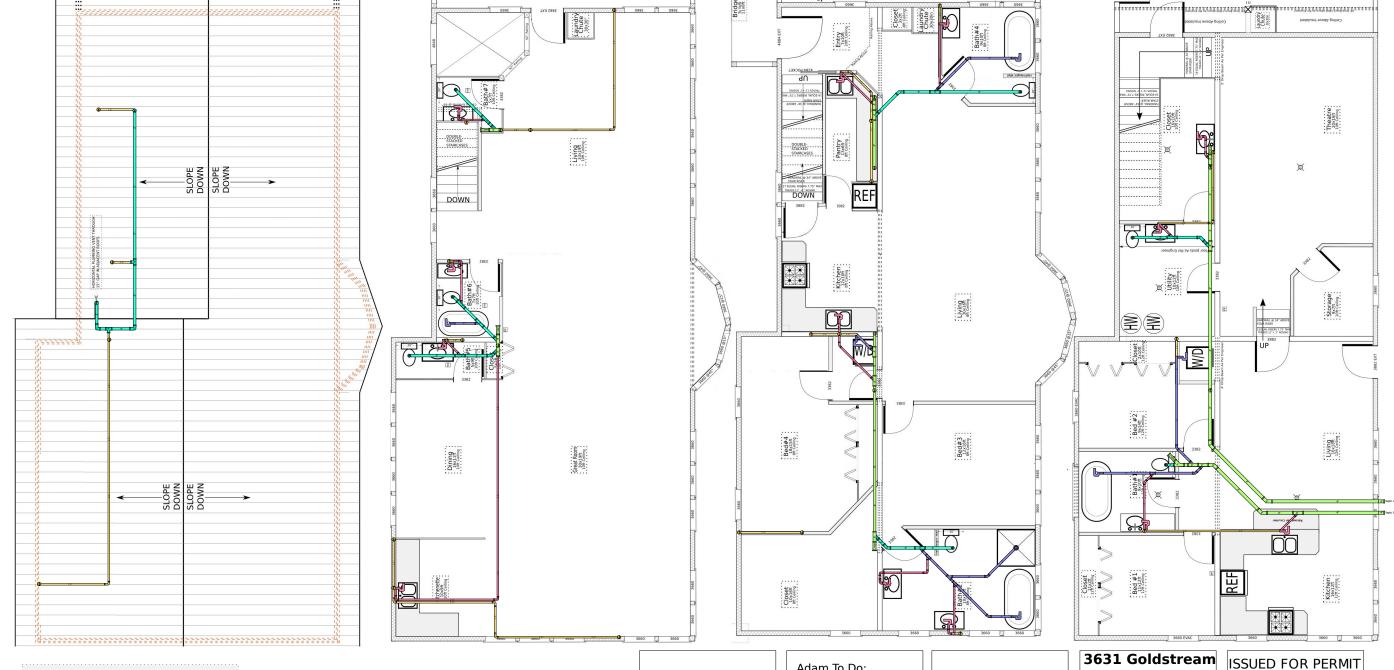

## **PLAN LEGEND**

- 1.5" KITCHEN OR BATHROOM SINK
- 2" LAUNDRY OUTLET W/ SEALED P-TRAP
- 2" BATHTUB DRAIN W/ SEALED P-TRAP
  2" SHOWER DRAIN W/ SEALED P-TRAP
- 3" TOILET FLANGE
- 4" CLEAN-OUT

#### Adam To Do: Nothing!




# Heights Dr. PROPOSED HOUSE

OWNER: ADAM WITHERS DATE: APRIL 21, 2024 SCALE: AS NOTED DESIGN: OWNER DRAWN: d.f

# **PLUMBING A-403**

PRINTED APR 26, 2024 ISSUED:

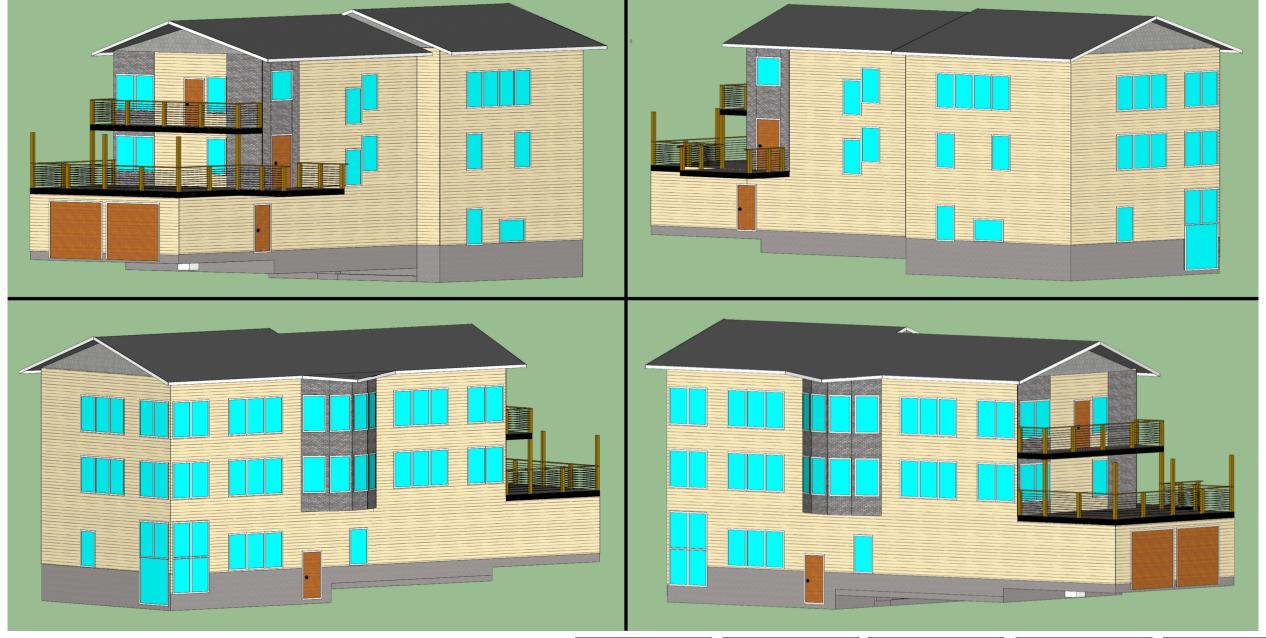

Adam To Do: Nothing!

# 3631 Goldstream Heights Dr. PROPOSED HOUSE

PROPOSED HOUSE
OWNER: ADAM WITHERS
DATE: APRIL 21, 2024
SCALE: AS NOTED
DESIGN: OWNER
DRAWN: d.f

ISSUED FOR PERMIT PRESPECTIVE

# RESPECTIVE VIEWS A-404

PRINTED APR 26, 2024 ISSUED:

# **OPENINGS SCHEDULE:**

ALL WINDOWS AND DOORS TO HAVE A MAXIMUM U-VALUE IN CONFORMANCE WITH BCBC 2024 TABLE 9.36.2.7.-A ENERGY MODEL ASSUMES DOUBLE-GLAZED, LOW E COATING, ARGON FILLED GLAZING; USI 1.30; SHGC 0.25;

#### 1ST FLOOR EXTERIOR WINDOWS:

131 FLOOR EXTERIOR WINDOWS:							
W100.1 W101.1 W102.1 W103.1 W103.2 W103.3 W104.1 W104.2 W104.3 W104.4 W104.5 W104.6 W104.7	ROOM NAME & NUMBER	WINDOW TYPE	WINDOW SIZE, FT-IN		WINDOW SIZE, mm		
			WIDTH	HEIGHT	WIDTH	HEIGHT	
W100.1	BATH #1	WIDE	5'0"	3'0"	914mm	1524mm	
W101.1	BED #2	EVAC	3'0"	5'0"	1524mm	914mm	
W102.1	STORAGE	TYP	3'0"	5'0"	1524mm	914mm	
W103.1	LIVING #1	TYP	3'0"	5'0"	1524mm	914mm	
W103.2	LIVING #1	TYP	3'0"	5'0"	1524mm	914mm	
W103.3	LIVING #1	TYP	3'0"	5'0"	1524mm	914mm	
W104.1	KITCHEN #1	TYP	3'0"	5'0"	1524mm	914mm	
W104.2	KITCHEN #1	TYP	3'0"	5'0"	1524mm	914mm	
W104.3	KITCHEN #1	UPPER	3'0"	5'0"	1524mm	914mm	
W104.4	KITCHEN #1	UPPER	3'0"	5'0"	1524mm	914mm	
W104.5	KITCHEN #1	UPPER	3'0"	5'0"	1524mm	914mm	
W104.6	KITCHEN #1	UPPER	3'0"	5'0"	1524mm	914mm	
W104.7	KITCHEN #1	TYP	3'0"	5'0"	1524mm	914mm	
W105.1	BED #1	EVAC	3'0"	5'0"	1524mm	914mm	

#### **2ND FLOOR EXTERIOR WINDOWS:**

ODENING NUMBER	ROOM NAME & NUMBER	WINDOW TYPE	WINDOW SIZE, FT-IN		WINDOW SIZE, mm	
OPENING NUMBER			WIDTH	HEIGHT	WIDTH	HEIGHT
W200.1	BED #4	TYP	3'0"	5'0"	1524mm	914mm
W200.2	BED #4	EVAC	3'0"	5'0"	1524mm	914mm
W201.1	KITCHEN #2	TYP	3'0"	5'0"	1524mm	914mm
W202.1	STAIRS	TYP	3'0"	5'0"	1524mm	914mm
W203.1	ENTRY	TYP	3'0"	5'0"	1524mm	914mm
W204.1	BATH #4	TYP	3'0"	5'0"	1524mm	914mm
W204.2	BATH #4	SAFETY	3'0"	5'0"	1524mm	914mm
W204.3	BATH #4	SAFETY	3'0"	5'0"	1524mm	914mm
W204.4	BATH #4	SAFETY	3'0"	5'0"	1524mm	914mm
W205.1	LIVING #2	TYP	3'0"	5'0"	1524mm	914mm
W205.2	LIVING #2	TYP	3'0"	5'0"	1524mm	914mm
W205.3	LIVING #2	TYP	3'0"	5'0"	1524mm	914mm
W205.4	BAY WINDOW	TYP	3'0"	5'0"	1524mm	914mm
W205.5	BAY WINDOW	TYP	3'0"	5'0"	1524mm	914mm
W205.6	BAY WINDOW	TYP	3'0"	5'0"	1524mm	914mm
W205.7	BAY WINDOW	TYP	3'0"	5'0"	1524mm	914mm
W206.1	BED #3	TYP	3'0"	5'0"	1524mm	914mm
W206.2	BED #3	TYP	3'0"	5'0"	1524mm	914mm
W206.3	BED #3	EVAC	3'0"	5'0"	1524mm	914mm
W207.1	BATH #2	SAFETY	3'0"	5'0"	1524mm	914mm
W207.2	BATH #2	SAFETY	3'0"	5'0"	1524mm	914mm
W207.3	BATH #2	SAFETY	3'0"	5'0"	1524mm	914mm
W207.4	BATH #2	TYP	3'0"	5'0"	1524mm	914mm
W207.5	BATH #2	TYP	3'0"	5'0"	1524mm	914mm
W208.1	CLOSET	TYP	3'0"	5'0"	1524mm	914mm

OPENING NUMBER	RIOR WINDOW ROOM NAME & NUMBER	WINDOW TYPE	WINDOW SIZE, FT-IN		WINDOW SIZE, mm	
			WIDTH	HEIGHT	WIDTH	HEIGHT
W300.1	DINING	TYP	3'0"	5'0"	1524mm	914mm
W300.2	DINING	TYP	3'0"	5'0"	1524mm	914mm
W300.3	DINING	TYP	3'0"	5'0"	1524mm	914mm
W300.4	DINING	TYP	3'0"	5'0"	1524mm	914mm
W301.1	STAIRS	TYP	3'0"	5'0"	1524mm	914mm
W301.2	STAIRS	TYP	3'0"	5'0"	1524mm	914mm
W302.1	ENTRY ABOVE	4-FOOT	4'0"	4'0"	1219mm	1219mm
W302.2	ENTRY ABOVE	TYP	3'0"	5'0"	1524mm	914mm
W303.1	LIVING #3	TYP	3'0"	5'0"	1524mm	914mm
W303.2	LIVING #3	TYP	3'0"	5'0"	1524mm	914mm
W303.3	LIVING #3	TYP	3'0"	5'0"	1524mm	914mm
W303.4	LIVING #3	TYP	3'0"	5'0"	1524mm	914mm
W303.5	LIVING #3	TYP	3'0"	5'0"	1524mm	914mm
W303.6	LIVING #3	TYP	3'0"	5'0"	1524mm	914mm
W303.7	LIVING #3	TYP	3'0"	5'0"	1524mm	914mm
W304.1	BAY WINDOW	TYP	3'0"	5'0"	1524mm	914mm
W304.2	BAY WINDOW	TYP	3'0"	5'0"	1524mm	914mm
W304.3	BAY WINDOW	TYP	3'0"	5'0"	1524mm	914mm
W304.4	BAY WINDOW	TYP	3'0"	5'0"	1524mm	914mm
W305.1	GREAT ROOM	TYP	3'0"	5'0"	1524mm	914mm
W305.2	GREAT ROOM	TYP	3'0"	5'0"	1524mm	914mm
W305.3	GREAT ROOM	TYP	3'0"	5'0"	1524mm	914mm
W305.4	GREAT ROOM	TYP	3'0"	5'0"	1524mm	914mm
W305.5	GREAT ROOM	TYP	3'0"	5'0"	1524mm	914mm
W305.6	GREAT ROOM	TYP	3'0"	5'0"	1524mm	914mm
W305.7	GREAT ROOM	TYP	3'0"	5'0"	1524mm	914mm
W305.8	GREAT ROOM	TYP	3'0"	5'0"	1524mm	914mm
W305.9	GREAT ROOM	TYP	3'0"	5'0"	1524mm	914mm
W305.10	GREAT ROOM	TYP	3'0"	5'0"	1524mm	914mm

#### **ALL EXTERIOR DOORS:**

OPENING NUMBER	ROOM NAME & NUMBER	DOOR TYPE	DOOR SIZE, FT-IN		DOOR SIZE, mm		
			WIDTH	HEIGHT	WIDTH	HEIGHT	
D100.1	GARAGE EXT	TYP	3'2"	6'10"	965mm	2082mm	
D100.2	GARAGE	TYP	9'0"	7'0"	2743mm	2134mm	
D100.3	GARAGE	TYP	9'0"	7'0"	2743mm	2134mm	
D100.4	GARAGE INT	TYP	3'2"	6'10"	965mm	2082mm	
D101.1	LIVING	TYP	3'2"	6'10"	965mm	2082mm	
D102.1	SLIDING	TYP	6'4"	6'8"	1930mm	2032mm	
D200.1	ENTRY	TYP	4'0"	7'0"	1219mm	2134mm	
D300.1	DECK	TYP	3'2"	6'10"	965mm	2082mm	

# **3631 Goldstream** ISSUED FOR PERMIT **Heights Dr.**PROPOSED HOUSE OWNER: ADAM WITHERS


DATE: MAY 29, 2024 SCALE: AS NOTED DESIGN: OWNER DRAWN: F.B.

# **OPENINGS SCHEDULE** A-408

## **ROOF ASSEMBLIES TYP:**

#### **VENTILATED SLOPED ROOF:**


- 12" STANDING SEAM METAL ROOFING
- SA MEMBRANE UNDERLAY (WEATHER BARRIER)
- 3/4" T+G ROOF PLY
- PREFABRICATED ROOF TRUSS [TBC BY APPLICANT]
- MINERAL WOOL BATT INSULATION (R31), FIBREGLASS BATT OR EQUIVALENT IS ACCEPTABLE WITH SIMILAR R/in
- 6 MIL. POLY (VAPOUR BARRIER)
- 1/2" GWB, PAINT FINISH

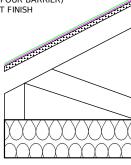

## FLOOR ASSEMBLIES TYP:

#### WOOD FRAMED FLOOR - WOOD FLOORING:

- 3/4" ENGINEERED WOOD FLOOR, C/W
- ACOUSTIC UNDERLAYMENT
- 3/4" PLYWOOD FLOOR SHEATHING
- 14" TJI-580 @ 16" O.C., C/W
- ACOUSTIC BATT INSULATION
- STRAPPING AS REO. - 1/2" GWB. PAINT FINISH

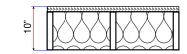

#### **CONCRETE SLAB ON GRADE - CRAWLSPACE FLOOR:**

- 2" CONCRETE GROUND SEAL ON GRADE; C/W CONCRETE SEALER
- 6 MIL POLY (VAPOUR BARRIER)
- 3" RIGID XPS INSULATION (R15)
- 6" COMPACTED GRANULAR FILL

SLOPE 1% MIN. TO DRAIN



# **EXT. WALL ASSEMBLIES TYP:**

#### **EXTERIOR FRAMED WALL - SPLIT INSULATION - 3/4" SIDING:**

- 3/4" SIDING
- 3/4" RAINSCREEN FURRING (BCBC 2024 9.27.5.3.)
- 1-1/2" CONTINUOUS MINERAL WOOL BOARD INSULATION (R5)
- VAPOUR PERMEABLE AWB
- 3/4" EXTERIOR GRADE SHEATHING
- 2 X 6 WOOD FRAMING @ 16" O.C. C/W
- MINERAL WOOL BATT INSULATION (R20), FIBREGLASS BATT OR EQUIVALENT IS ACCEPTABLE WITH SIMILAR R/in
- 6 MIL. POLY (VAPOUR BARRIER)
- 1/2" GWB, PAINT FINISH (TYP); REPLACE 1/2" GWB W/ 5/8" TYPE X GWB WHERE 1 HR FRR IS REQUIRED AS INDICATED; REPLACE WITH 1/2" GWB WITH TILE & CEMENTICIOUS BACKER BOARD IN WET LOCATIONS AS REQ.

#### **EXTERIOR CONCRETE WALL - CAST-IN-PLACE OR ICF FOUNDATION ABOVE:**

- PARGING
- CEMENTICIOUS BACKING BOARD
- WATERPROOF MEMBRANE
- 2" CONTINUOUS EPS INSULATION (R12)
- C.I.P. 8" CONCRETE WALL
- 2" CONTINUOUS EPS INSULATION (R12)

#### **EXTERIOR CONCRETE WALL - CAST-IN-PLACE OR ICF FOUNDATION BELOW GRADE:**

- CEMENTICIOUS BACKING BOARD
- WATERPROOF MEMBRANE
- 2" CONTINUOUS EPS INSULATION (R12) - C.I.P. 8" CONCRETE WALL - 2" CONTINUOUS EPS INSULATION (R12)

# **INT. WALL ASSEMBLIES TYP:**


#### **INTERIOR FRAMED WALL - 2 X 4:**

- 1/2" GWB, PAINT FINISH
- 2 X 4 WOOD FRAMING @ 16" O.C. C/W - ACOUSTIC BATT INSULATION
- 1/2" GWB, PAINT FINISH



#### **INTERIOR FRAMED WALL - 2 X 6:**

- 1/2" GWB, PAINT FINISH
- 2 X 6 WOOD FRAMING @ 16" O.C. C/W ACOUSTIC BATT INSULATION
- 1/2" GWB, PAINT FINISH

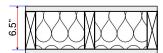

### **3631 Goldstream** ISSUED FOR PERMIT Heights Dr. PROPOSED HOUSE OWNER: ADAM WITHERS

DATE: MAY 29, 2024 SCALE: AS NOTED DESIGN: OWNER DRAWN: F.B.

# **OPENINGS SCHEDULE**

A-408

**PRINTED MAY 29, 2024** 

ISSUED: